

GENERAL NOTES

1. THE BUILDING SHALL BE CONSTRUCTED IN ACCORDANCE WITH THE 2012 INTERNATIONAL BUILDING CODE (IBC) AND THE 2012 INTERNATIONAL MECHANICAL AND ELECTRICAL PLUMBING CODE (IMC).
2. THE CONTRACTOR SHALL VERIFY ALL DIMENSIONS AND CONDITIONS IN THE FIELD PRIOR TO COMMENCEMENT OF WORK. THE CONTRACTOR SHALL BE RESPONSIBLE FOR OBTAINING ALL NECESSARY PERMITS AND APPROVALS FROM THE APPLICABLE AGENCIES.
3. ALL MATERIALS AND METHODS OF CONSTRUCTION SHALL BE APPROVED BY THE ARCHITECT PRIOR TO INSTALLATION.
4. THE CONTRACTOR SHALL MAINTAIN ACCESS TO ALL UTILITIES AND EXISTING STRUCTURES AT ALL TIMES.
5. THE CONTRACTOR SHALL BE RESPONSIBLE FOR OBTAINING ALL NECESSARY PERMITS AND APPROVALS FROM THE APPLICABLE AGENCIES.

CONCRETE

1. CONCRETE SHALL BE PLACED AND FINISHED IN ACCORDANCE WITH THE 2012 INTERNATIONAL BUILDING CODE (IBC).
2. THE CONTRACTOR SHALL VERIFY ALL DIMENSIONS AND CONDITIONS IN THE FIELD PRIOR TO COMMENCEMENT OF WORK.
3. ALL MATERIALS AND METHODS OF CONSTRUCTION SHALL BE APPROVED BY THE ARCHITECT PRIOR TO INSTALLATION.
4. THE CONTRACTOR SHALL MAINTAIN ACCESS TO ALL UTILITIES AND EXISTING STRUCTURES AT ALL TIMES.
5. THE CONTRACTOR SHALL BE RESPONSIBLE FOR OBTAINING ALL NECESSARY PERMITS AND APPROVALS FROM THE APPLICABLE AGENCIES.

STEEL

1. STEEL SHALL BE PLACED AND FINISHED IN ACCORDANCE WITH THE 2012 INTERNATIONAL BUILDING CODE (IBC).
2. THE CONTRACTOR SHALL VERIFY ALL DIMENSIONS AND CONDITIONS IN THE FIELD PRIOR TO COMMENCEMENT OF WORK.
3. ALL MATERIALS AND METHODS OF CONSTRUCTION SHALL BE APPROVED BY THE ARCHITECT PRIOR TO INSTALLATION.
4. THE CONTRACTOR SHALL MAINTAIN ACCESS TO ALL UTILITIES AND EXISTING STRUCTURES AT ALL TIMES.
5. THE CONTRACTOR SHALL BE RESPONSIBLE FOR OBTAINING ALL NECESSARY PERMITS AND APPROVALS FROM THE APPLICABLE AGENCIES.

MECHANICAL

1. MECHANICAL SYSTEMS SHALL BE INSTALLED IN ACCORDANCE WITH THE 2012 INTERNATIONAL MECHANICAL AND ELECTRICAL PLUMBING CODE (IMC).
2. THE CONTRACTOR SHALL VERIFY ALL DIMENSIONS AND CONDITIONS IN THE FIELD PRIOR TO COMMENCEMENT OF WORK.
3. ALL MATERIALS AND METHODS OF CONSTRUCTION SHALL BE APPROVED BY THE ARCHITECT PRIOR TO INSTALLATION.
4. THE CONTRACTOR SHALL MAINTAIN ACCESS TO ALL UTILITIES AND EXISTING STRUCTURES AT ALL TIMES.
5. THE CONTRACTOR SHALL BE RESPONSIBLE FOR OBTAINING ALL NECESSARY PERMITS AND APPROVALS FROM THE APPLICABLE AGENCIES.

ELECTRICAL

1. ELECTRICAL SYSTEMS SHALL BE INSTALLED IN ACCORDANCE WITH THE 2012 NATIONAL ELECTRICAL CODE (NEC).
2. THE CONTRACTOR SHALL VERIFY ALL DIMENSIONS AND CONDITIONS IN THE FIELD PRIOR TO COMMENCEMENT OF WORK.
3. ALL MATERIALS AND METHODS OF CONSTRUCTION SHALL BE APPROVED BY THE ARCHITECT PRIOR TO INSTALLATION.
4. THE CONTRACTOR SHALL MAINTAIN ACCESS TO ALL UTILITIES AND EXISTING STRUCTURES AT ALL TIMES.
5. THE CONTRACTOR SHALL BE RESPONSIBLE FOR OBTAINING ALL NECESSARY PERMITS AND APPROVALS FROM THE APPLICABLE AGENCIES.

PLUMBING

1. PLUMBING SYSTEMS SHALL BE INSTALLED IN ACCORDANCE WITH THE 2012 INTERNATIONAL PLUMBING CODE (IPC).
2. THE CONTRACTOR SHALL VERIFY ALL DIMENSIONS AND CONDITIONS IN THE FIELD PRIOR TO COMMENCEMENT OF WORK.
3. ALL MATERIALS AND METHODS OF CONSTRUCTION SHALL BE APPROVED BY THE ARCHITECT PRIOR TO INSTALLATION.
4. THE CONTRACTOR SHALL MAINTAIN ACCESS TO ALL UTILITIES AND EXISTING STRUCTURES AT ALL TIMES.
5. THE CONTRACTOR SHALL BE RESPONSIBLE FOR OBTAINING ALL NECESSARY PERMITS AND APPROVALS FROM THE APPLICABLE AGENCIES.

GENERAL CONTRACTOR


1. THE CONTRACTOR SHALL BE RESPONSIBLE FOR OBTAINING ALL NECESSARY PERMITS AND APPROVALS FROM THE APPLICABLE AGENCIES.
2. THE CONTRACTOR SHALL MAINTAIN ACCESS TO ALL UTILITIES AND EXISTING STRUCTURES AT ALL TIMES.
3. THE CONTRACTOR SHALL BE RESPONSIBLE FOR OBTAINING ALL NECESSARY PERMITS AND APPROVALS FROM THE APPLICABLE AGENCIES.

ISSUE LOG

NO.	DATE	DESCRIPTION
1	07/11/2012	APPROVAL
2	08/22/2012	CONTRACTOR COMMENTS
3	10/03/2012	SCOPE REDUCTION

CONSULTANTS

CONSULTANT: CONSULTING ENGINEERS & ARCHITECTS
 11210 Shepherd Dr., Ste 202
 Houston, Texas 77066
 Phone: 282-678-2110 ext. 15
 Email: CE@cehouston.com
 TYPE Form No. 4385

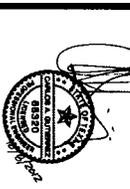


PROJECT NAME:
 Houston Police Academy
 Indoor Shooting Range
 17000 Adline Westfield Road
 Building "E"
 Houston, Texas 77073
 Foundation Repair

CITY OF HOUSTON
 GENERAL SERVICES
 DEPARTMENT

DATE: OCTOBER 8, 2012
 SCALE: N.T.S.
 DRAWN BY: DMSM
 CHECKED BY: CAD

SHEET NO.:
 STRUCTURAL
 GENERAL NOTES
 S0.0
 CITY DWG. NO.:

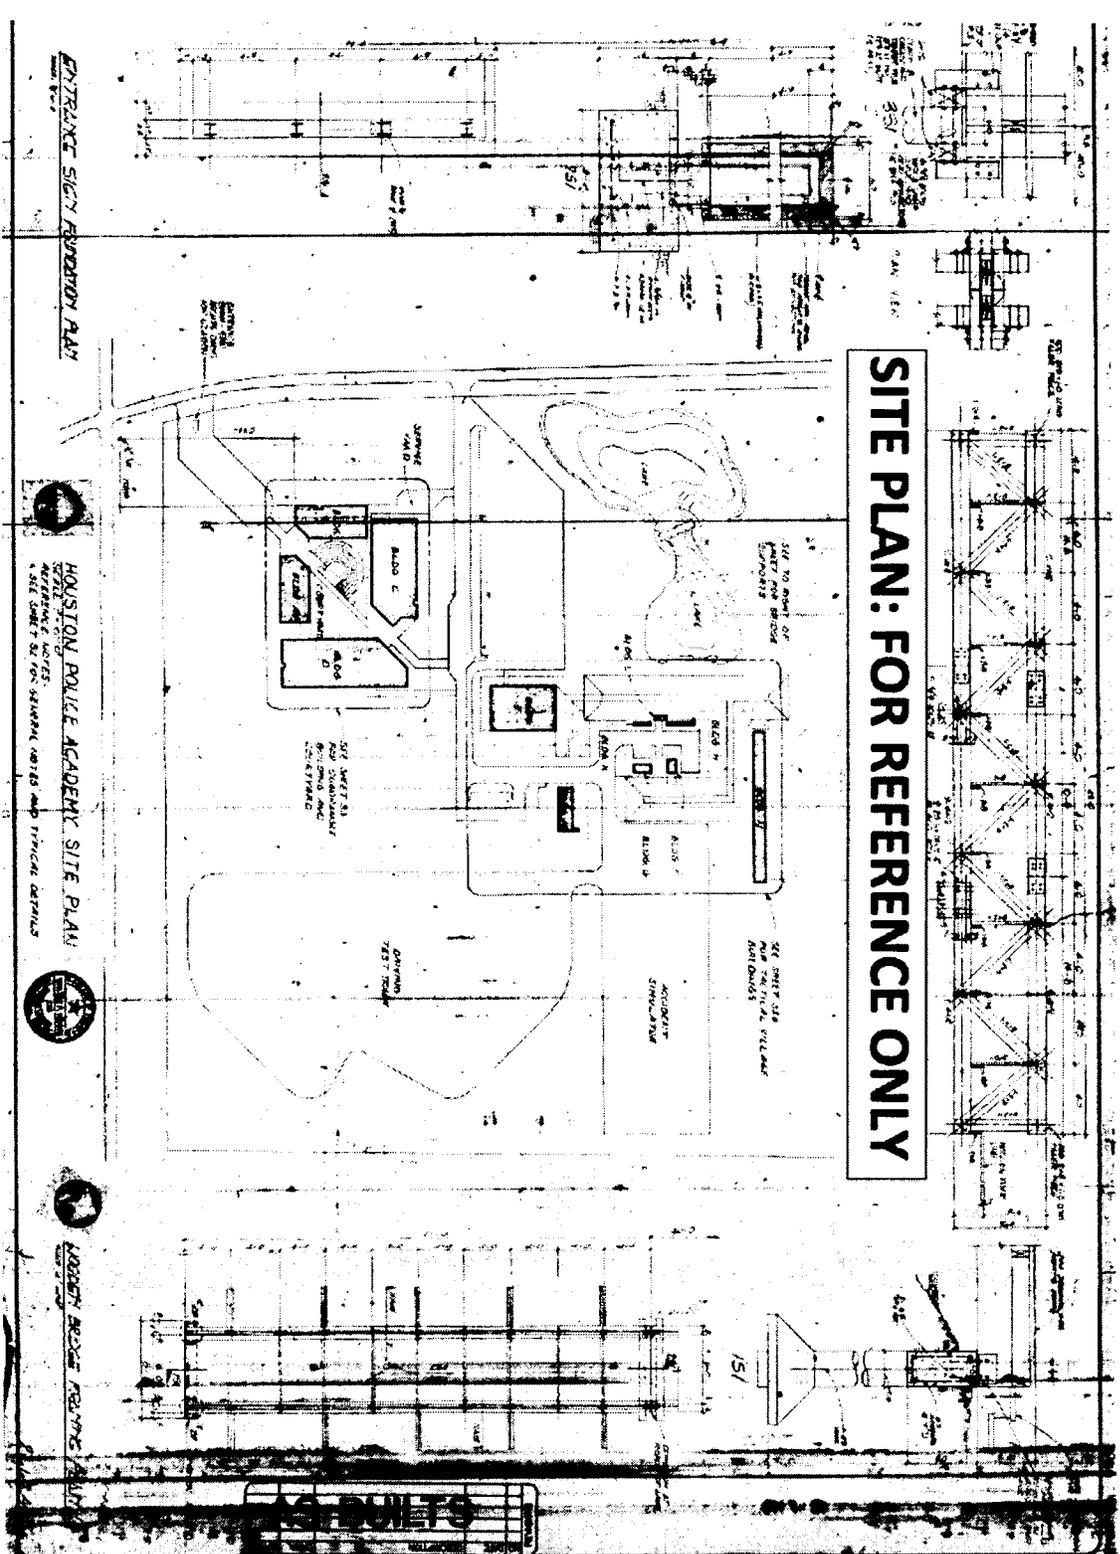

SITE PLAN: FOR REFERENCE ONLY

ENTRANCE SIGN REVISION PLAN

HOUSTON POLICE ACADEMY SITE PLAN

ROBBERY RANGE REVISION

ISSUE LOG		
NO.	DATE	DESCRIPTION
1	04.08.2012	APPROVAL
2	07.11.2012	REVISION
3	08.27.2012	CON COMMENTS
4	10.08.2012	SCORE REDUCTION


<p>CONSULTANT(S):</p> <p>Structural: CPT Consulting LP 17000 Adline Westfield Road Houston, Texas 77058 Phone: 282-872-2116 ext. 15 Cell: 713-685-1751 P.E. TBE# Perm No. 42881</p>	<p>ENGINEER:</p> <p>THE SPORSTY PARTNERSHIP ARCHITECTS, INC. 17000 Adline Westfield Road Houston, Texas 77058 Phone: 282-872-2116 ext. 15 Cell: 713-685-1751 P.E. TBE# Perm No. 42881</p>
--	--

<p>CITY OF HOUSTON GENERAL SERVICES DEPARTMENT</p>	<p>PROJECT NAME: Houston Police Academy Indoor Shooting Range 17000 Adline Westfield Road Building 7 Houston, Texas 77073 Foundation Repair</p>
--	---

<p>DATE: OCTOBER 8, 2012</p> <p>SCALE: A1/8" = 1'-0"</p> <p>DRAWN BY: JESAL</p> <p>CHECKED BY: CMO</p> <p>SHEET TITLE: SITE PLAN</p>	<p>SHEET NO.: S0.1</p> <p>CITY DWG. NO.:</p>
---	--



EXISTING FOUNDATION SLAB TOPOGRAPHY

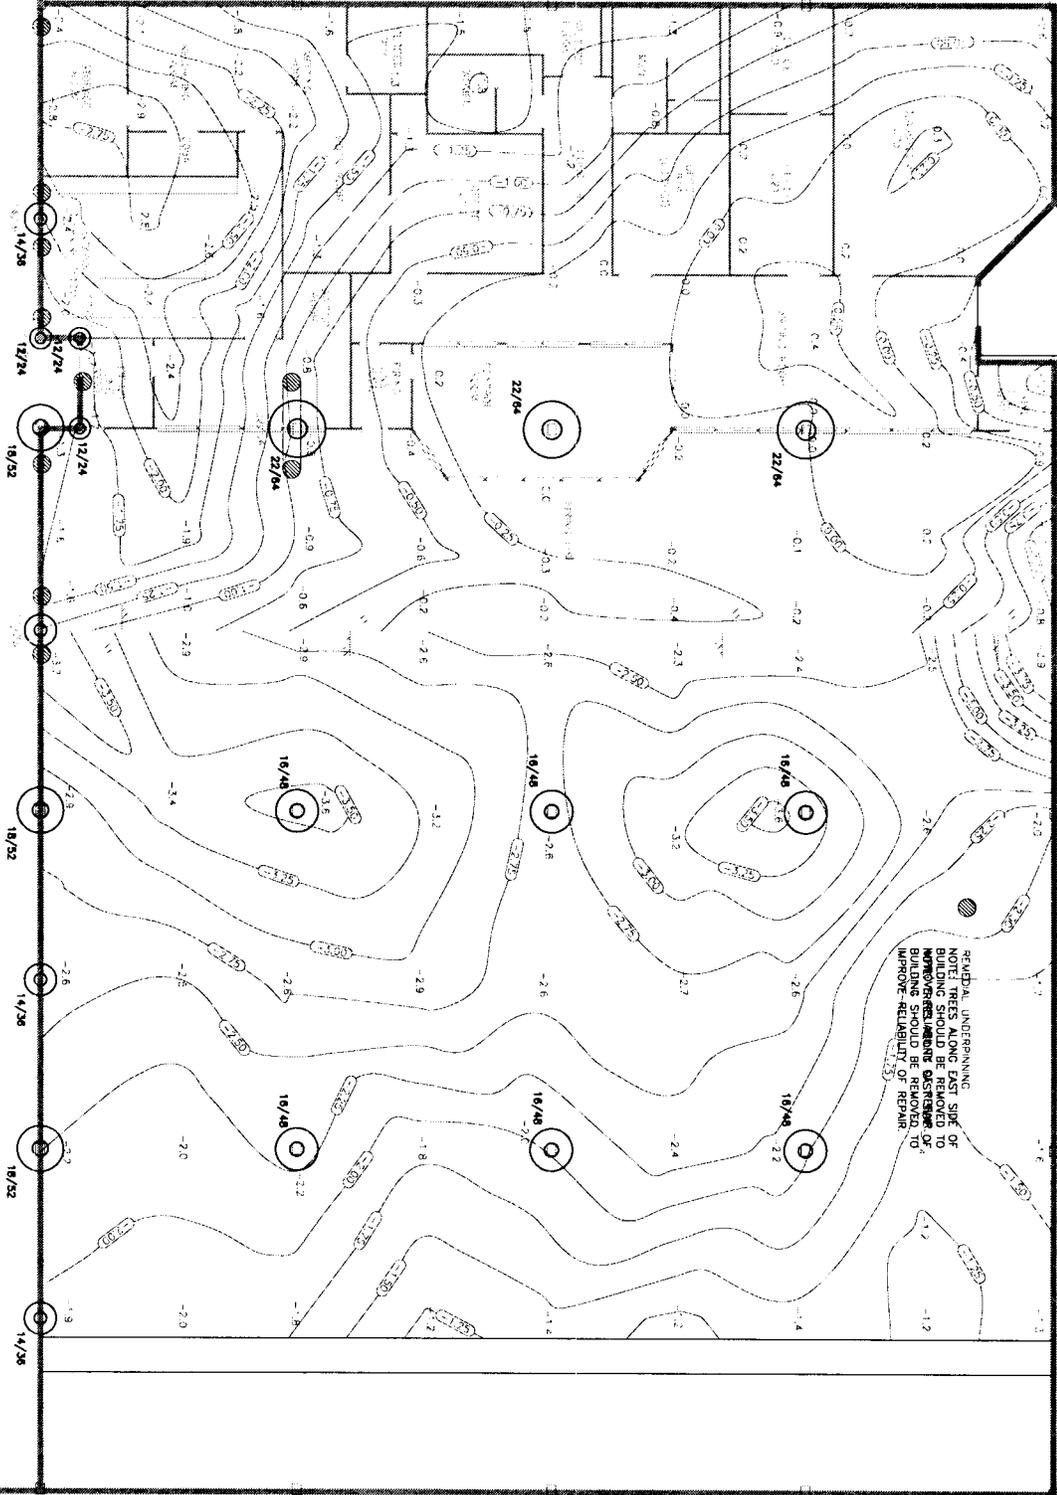


REMEDIAL UNDERPINNING
 NOTE: TREES ALONG EAST SIDE OF
 BUILDING SHOULD BE REMOVED TO
 PREVENT REMAINING UNDERPINNING
 FROM BEING DAMAGED. THIS SHOULD
 IMPROVE RELIABILITY OF REPAIR.

ISSUE LOG

NO.	DATE	DESCRIPTION
A	04/08/2012	APPROVAL
0	07/11/2012	PERMIT
1	08/27/2012	CON COMMENTS
2	10/08/2012	SCORE REDUCTION

CONSULTANT(S): Consulting, L.P.
 11210 Shepherd Dr., Ste 202
 Houston, Texas 77066
 Phone: 282-878-2110 ext. 15
 Fax: 282-878-2111
 Contact: Christopher P.E.
 TREF Perm No. 4385

ENGINEER

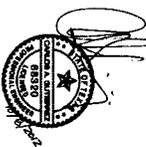


PROJECT NAME:
 Houston Police Academy
 Indoor Shooting Range
 17000 Aldine Westfield Road
 Building "E"
 Houston, Texas 77073
 Foundation Repair

**CITY OF HOUSTON
 GENERAL SERVICES
 DEPARTMENT**

REVIEWED: _____
 DATE: OCTOBER 8, 2012
 SCALE: 3/16" = 1'-0"
 DRAWN BY: DESJAN
 CHECKED BY: CDS
 SHEET TITLE:
 EXISTING CONDITIONS

SHEET NO.:
S1.0

CITY DWG. NO.:

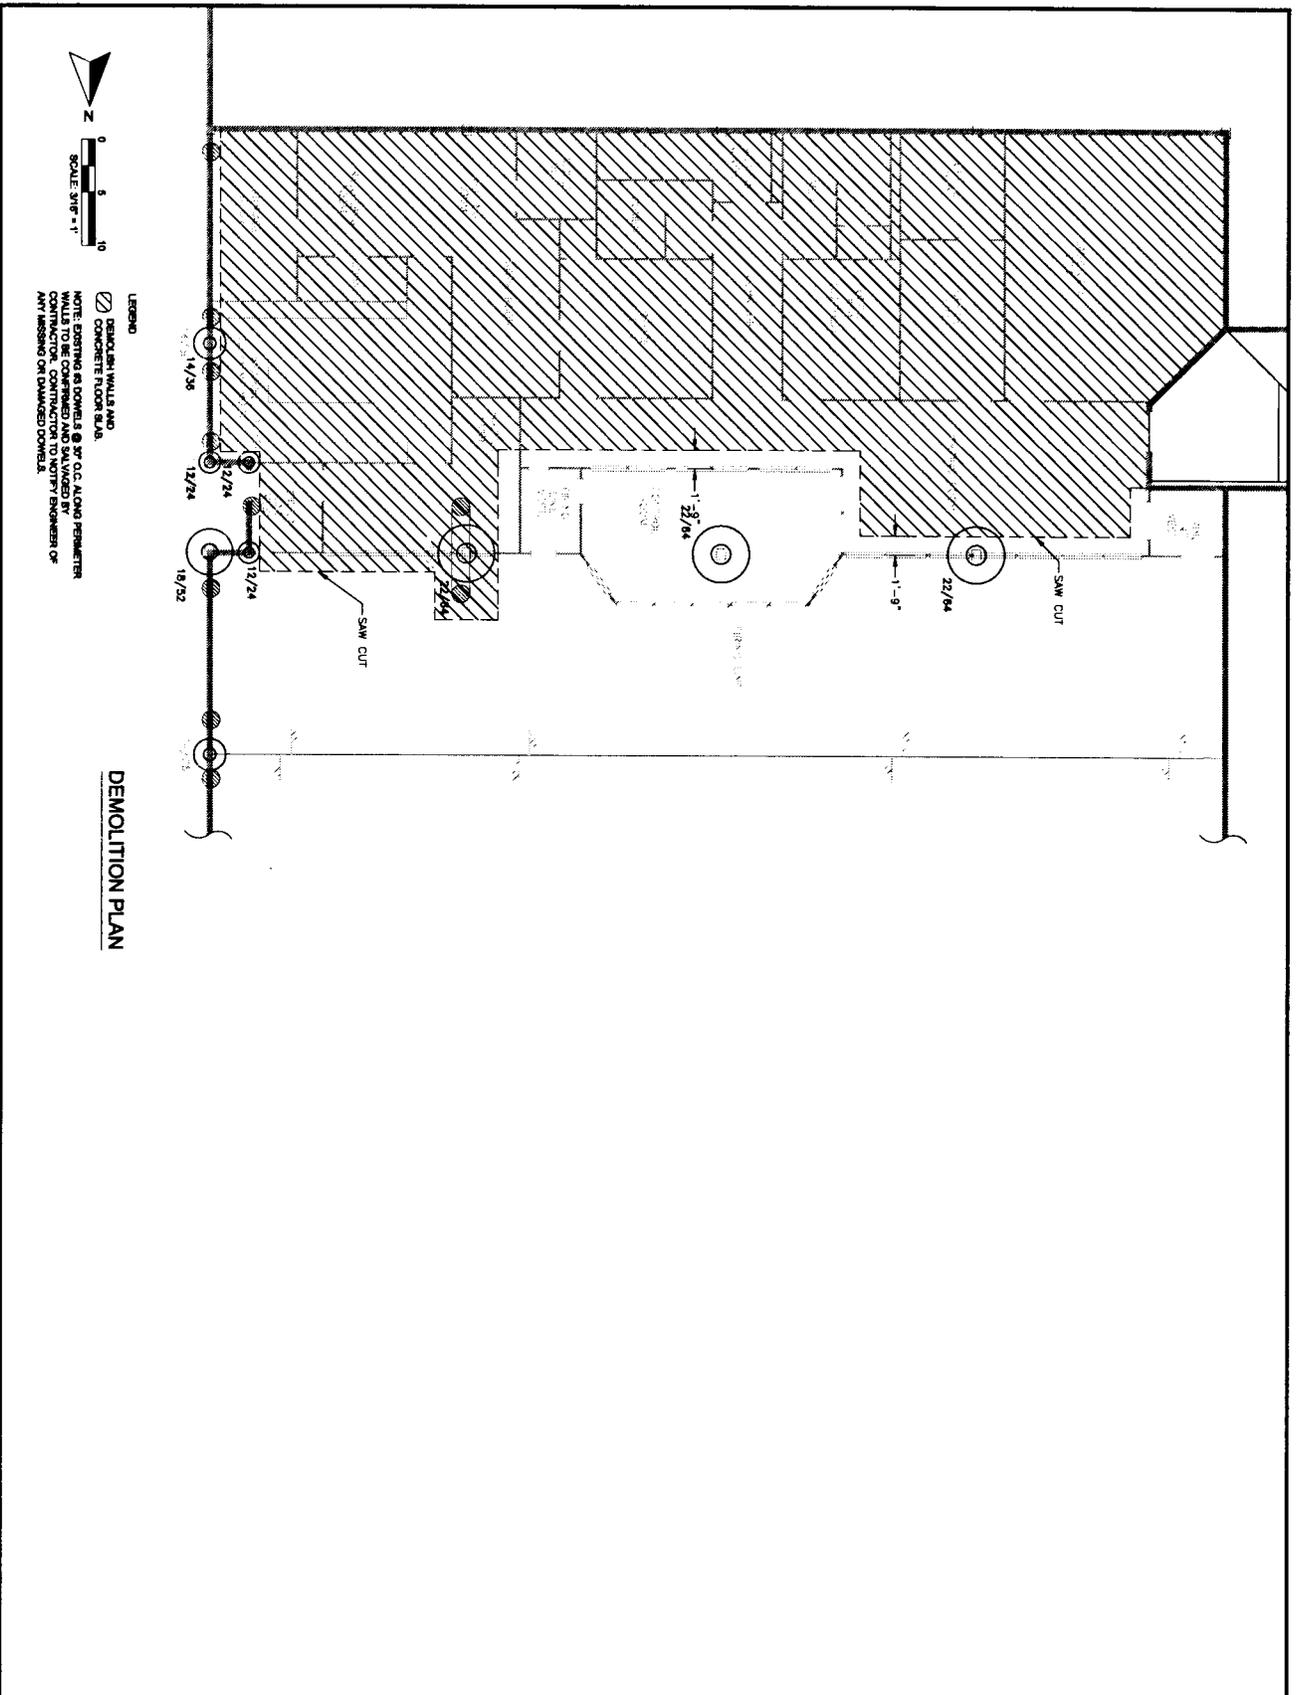

LEGEND

 DEMOLISH WALLS AND CONCRETE FLOOR SLAB.
 WALLS TO BE COMPEDED AND SALVAGED BY CONTRACTOR.
 ANY MISSING OR DAMAGED DOORS.

NOTE: EXISTING AS DOWNED AND SALVAGED BY CONTRACTOR. ANY MISSING OR DAMAGED DOORS.



DEMOLITION PLAN

ISSUE LOG

NO.	DATE	DESCRIPTION
A	04.08.2012	APPROVAL
0	07.11.2012	PERMIT
1	08.27.2012	CON COMMENTS
2	10.08.2012	SCOPE REDUCTION

CONSULTANT: CONSULTING, L.P.
 11210 Sheppard Dr., Ste 202
 Houston, Texas 77066
 Phone: 832-419-2110 ext. 15
 Fax: 832-419-2111
 Contact: Cory Walker, P.E.
 TBE Firm No. 4586

ENGINEER



PROJECT NAME:
 Houston Police Academy
 Indoor Shooting Range
 17000 Audine Westfield Road
 Building "E"
 Houston, Texas 77073
 Foundation Repair

CITY OF HOUSTON
 GENERAL SERVICES
 DEPARTMENT

REVIEWED:
 PROJECT NUMBER: _____
 DRAWING NUMBER: _____
 DATE: OCTOBER 8, 2012

DATE: OCTOBER 8, 2012
SCALE: 3/16" = 1'
DRAWN BY: DRSJAM
CHECKED BY: CAG

SHEET TITLE:
 DEMOLITION PLAN

SHEET NO.:
 S2.0

CITY DWG. NO.:

